AIRPORT GATEWAY at Goodyear

Comprehensive Sign Program 08-630-00007

Approved November 6, 2008 CSP Amendment 19-630-00003 Dated October, 2019

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Introduction

The Airport Gateway at Goodyear is located on the northeast corner of Bullard Avenue and Van Buren Street, adjacent to the I-10 freeway. It is a Mixed-Use development with a variety of commercial uses including office, hotel, medical, restaurant, and retail. The project is zoned preliminary PAD, with the portion of the project located at the northeast corner Fillmore Street and 143rd Avenue being zoned final PAD.

This Comprehensive Sign Program has been established for the overall project identification totaling approximately 212 acres of area. The sign program contained herein has been developed with the purpose of assuring an outstanding experience to the mutual benefit of the general public and all Airport Gateway at Goodyear tenants.

Properly adhered to, the criteria will ensure that project and tenant identification is consistent in quality, and is compatible with the overall architectural character of the project and surrounding neighborhoods.

Each individual development within the site shall develop their own sign package that suits the use of their site. The guidelines as laid out in this package are to be adhered to, with allowed flexibility in design and colors and materials. Close attention shall be paid, however, to the theme of the overall site, with approvals necessary from ownership and the City of Goodyear. **Project Colors and Materials**

The sign system is designed to promote a cohesive design package throughout the project.

The project colors used in the architectural package will also be used throughout the signage package to unify the signage with the site.

The colors provided below represent those used for overall project signage, however, individual parcels and users will develop their own individual sign packages where colors and materials may vary according to the architectural palette of the specific development.

The more bold colors will be used in areas that will not be changed to maintain a consistency in the signage elements.

Lighter colors in the palette will be used in the area where tenants could change. Lighter colors will not exhibit as much color change when new panels are placed adjacent to older ones.

DUNN EDWARDS
"Sand Dollar"
DE6171

DUNN EDWARDS
"S'mores"
DE6111

Painted to match

custom color -

"Hemlock"

McDowell Road

ADDED THIS
PARCEL

Airport Gateway
at Goodyear

Van Buren Street

Owners:
CHEYENNE VALLE YLLC, a Nevada limited liability company
OXNARD COMMERCEPLEX LLC, a Delaware limited liability
company

19TH AVENUE LLC, a Delaware limited liability company BULLARD II PROPERTIES I LLC, a Delaware limited liability company

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REV 6/2019

AIRPORT GATEWAY

at Goodyear

Freestanding Sign Matrix

User Type	Туре	Location	Quantity	Maximum Height	Maximum Area	Description	Materials/Illumination
Master Development (signage types allowed throughout the development)	Freeway Pylon (Sign Type 1) (office, commercial and medical uses)*	Adjacent to Interstate 10 Freeway as per plans.	Three (3)	80 Feet	Total Signage, per face, not to exceed 45% of the gross sign area	Identification	Masonry, aluminum, acrylic, paint/finish Illumination to be internal, halo or combination of the two
	Corner ID Monument (Sign Type 2)	NE and SW corner of Bullard Avenue and Van Buren Street, as well as the corners of significant intersections throughout the project.	Eight (8)	6 feet	60 s.f.		Masonry, paint/finish Illumination to be halo, ground up-lit or combination of the two
	Entry Wall ID (Sign Type 3)	Primary entrances into the project along Bullard Avenue and Van Buren Street.	Four (4) entries (one on each side of entry)	6 feet	32 s.f. per side	Identification of Master Development Only	
	On-site Campus Directory (Sign Type 4)	As per specific development plans.	As required to provide safe traffic flow	6 feet 6 inches	32 s.f.	buildings, facilities, etc.	Masonry, aluminum, vinyl, paint/finish Ground up-lit or non-
							illuminated
Retail/Commercial	Multi-Tenant Monument	As per specific development plans.	Two (2) per street frontage	20 feet	120 s.f.	Up to six (6) tenant panels and identification of project	Masonry, aluminum, acrylic, paint/finish
	Single-Tenant Monument (banks, restaurants and fuel stations)		One (1) per street frontage	6 feet	60 s.f.	i acritification of terialit	Illumination to be internal, halo or combination of the two
	On-site Directionals		As required to provide safe traffic flow	4 feet	12 s.f.	Information for private, public, delivery entrances and exits.	Aluminum, vinyl, paint/finish Non-illuminated
Mixed Use Office/Medical	Single-Tenant Building Monument	As per specific development plans.	One (1) per street frontage	6 feet	60 s.f.	Identification of tenant	Masonry, aluminum, acrylic, paint/finish
	Multi-Tenant Building Monument		One (1) per street frontage	10 feet	80 s.f.	inay contain racintineation of	Illumination to be internal, halo, ground up-lit or
	Multi-Tenant/Building Monument (for multi-building developments)		Two (2) per street frontage	10 feet	80 s.f.	Up to eight (8) tenant panels and identification of project	combination
	On-site Directionals		As required to provide safe traffic flow	4 feet	12 s.f.	Information for private, public, delivery entrances and exits.	Aluminum, vinyl, paint/finish
CTCA Off Premise	ST-2A hospital identification and future multi-tenant identification	NW corner of Litchfield Road and Celebrate Life Way (Fillmore)	One (1)	20 feet	250 s.f.	Hospital identification and future multi-tenant identification	Stone veneer, textured alum, acrylic. Internal illumination

^{*}Pylon signage under separate review and use permit.


Sign locations must be delineated at time of Final Site Plan review for each individual future development.

Setbacks

No signs shall be located in any right of way or site visibility triangle. All signs to be located at least 5 feet back of any public utility easement



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NOTE: Pylon signage under separate review and use permit application.

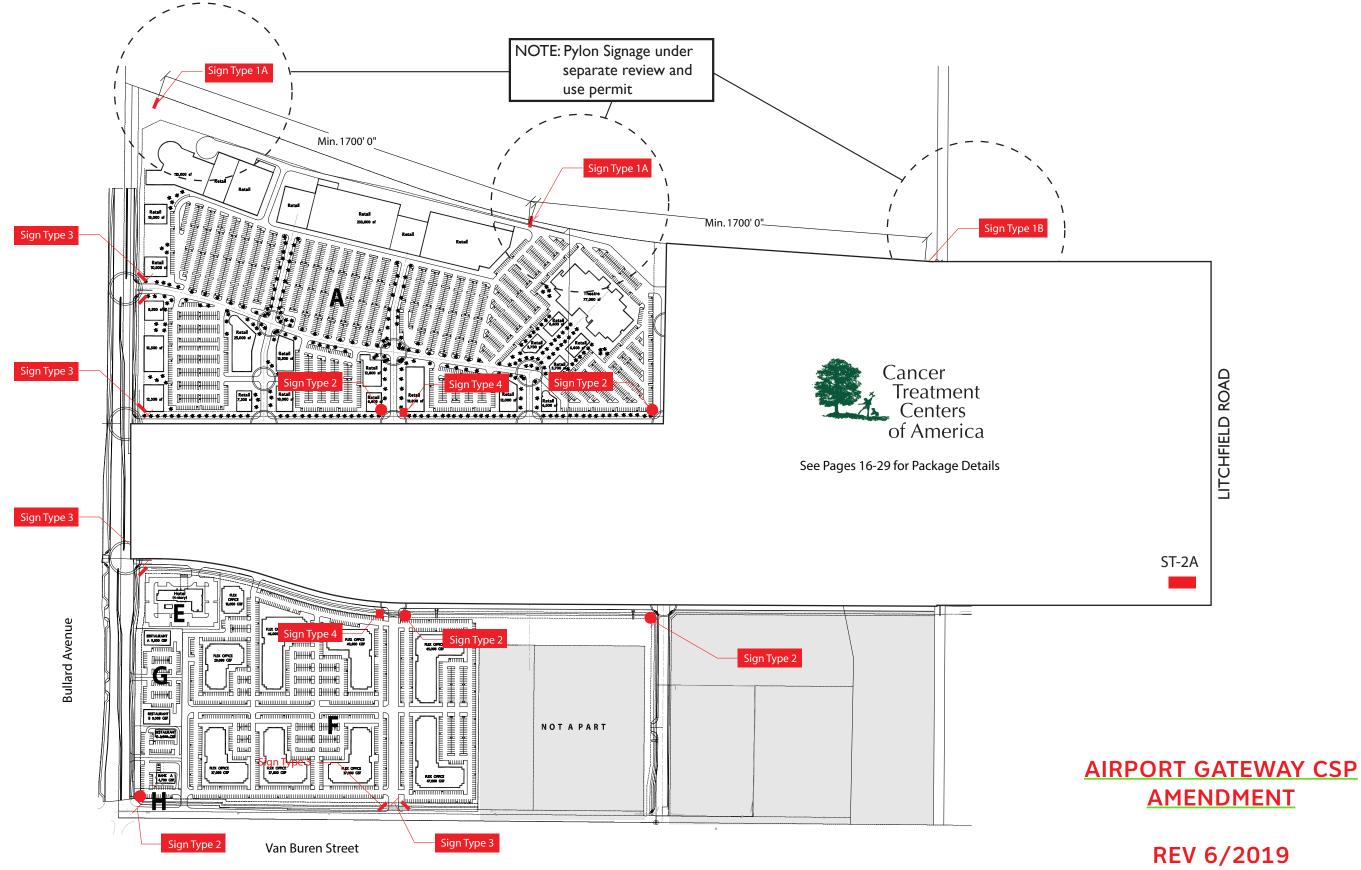There will be three pylons located in the northern portion of the project along the I-10 freeway, as noted on the sign location plan on page 4. These signs will serve primarily to identify hotel and retail establishments, but may also display prominent office and medical tenants as well. The freeway pylons are a key element for site recognition, containing the name of the project and up to six tenants. Landscaping requirements will be addressed and adhered to upon further development of the site in which the sign is located.

Sizes

Overall Height: 80'-0"

ID Panel: 27'-6"x6'-3" 172 s.f.

20'-2"x6'-0" 6 at 122 s.f. each Tenant Panel:

Construction

Structure: Finished aluminum fabrication over pole

footings as required.

ID/Tenant Panels: Finished aluminum fabrication - routed

copy with push-thru acrylic.

One space to contain digital message board that will display tenant advertising at the frequency of 4 messages per minute. The message board on Pylon IB shall display events and happenings at the hospital, and as events may not change frequently, the same message may be in place for days or weeks at a

Aluminum fabrication painted with Cap Details:

designated colors.


Colors

Sand Dollar and S'mores Structure:


ID/Tenant Panels: Sand Dollar

Painted to match Hemlock Cap Details:

Internal, halo or combination Illumination

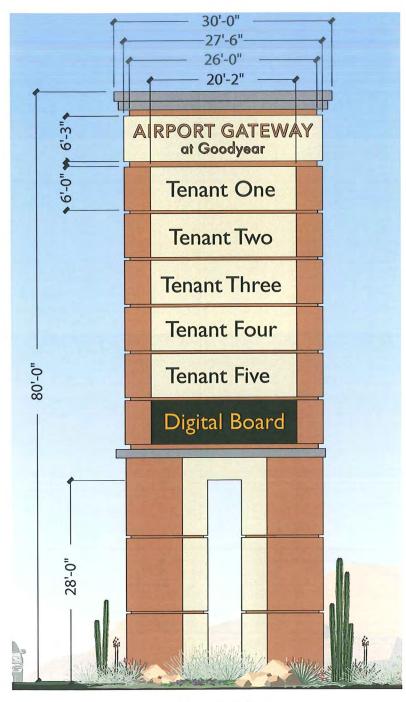

Pylon IA

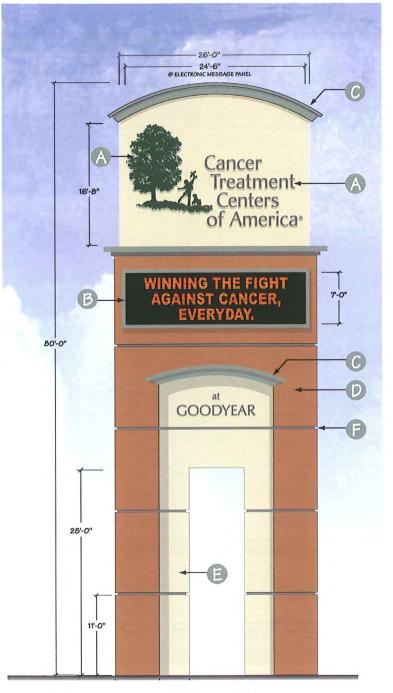

Pylon IB

Pylon IB Specifications

- INTERNALLY ILLUMINATED REVERSE PAN CHANNEL LETTERS WITH LED "HALO" ILLUMINATION
- LED ILLUMINATED MESSAGE PANEL
- DECORATIVE CORNICE TEXTURED AND PAINTED TO MATCH HEMLOCK GREEN
- ALUMINUM POLE COVER TEXTURED AND PAINTED TO MATCH DRIVIT 375 SPICE TAN
- ALUMINUM POLE COVER TEXTURED AND PAINTED TO MATCH DRIVIT 449 BUCKSKIN
- ALUMINUM REVEAL TEXTURED AND PAINTED TO MATCH HEMLOCK GREEN

Sign Type 2 - Corner ID Monument

This sign type will be located at the southwest corner of the project at the Bullard Avenue and Van Buren Street intersection, as well as the corners of significant intersections throughout the project. This sign should be used only to identify the project, however, a substantial user located at such corner may be permitted to use such sign to display their project identification (both logo and company name) with approval from the Owner and the City of Goodyear. In any case, the sign shall be integrated into the surrounding landscaping.

Sizes

Overall Height: 6'-0"

ID Area:

25'-0"x3'-3" 80 s.f.

Construction

Structure:

Masonry fabrication.

ID Letters:

Reverse pan channel dimensional letters,

pin mounted off surface.

Colors


Structure:

Sand Dollar and S'mores

S'mores **ID** Letters:

Illumination

Halo, ground up-lit or combination

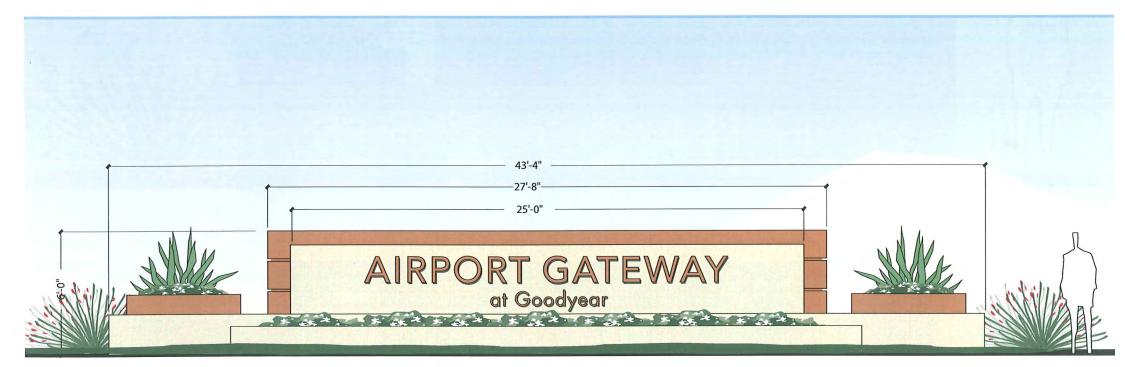

Sign Type 3 - Entry Wall ID Monument

This sign type will be located at the entries to the project on Bullard Avenue and Van Buren Street. This sign shall be used only to identify the project entry and shall be integrated into the surrounding landscaping.

Sizes

Overall Height: 6'-0"

ID Area: Airport Gateway: 14'-3"x2'-0"

> at Goodyear: 4'-4"x9" Total 32 s.f. per side

Construction

Masonry fabrication. Structure:

ID Letters: Reverse pan channel or flat cut-out


letters, pin mounted off surface.


Colors

Sand Dollar and S'mores Structure:

ID Letters: Sand Dollar

Halo, ground up-lit or combination Illumination

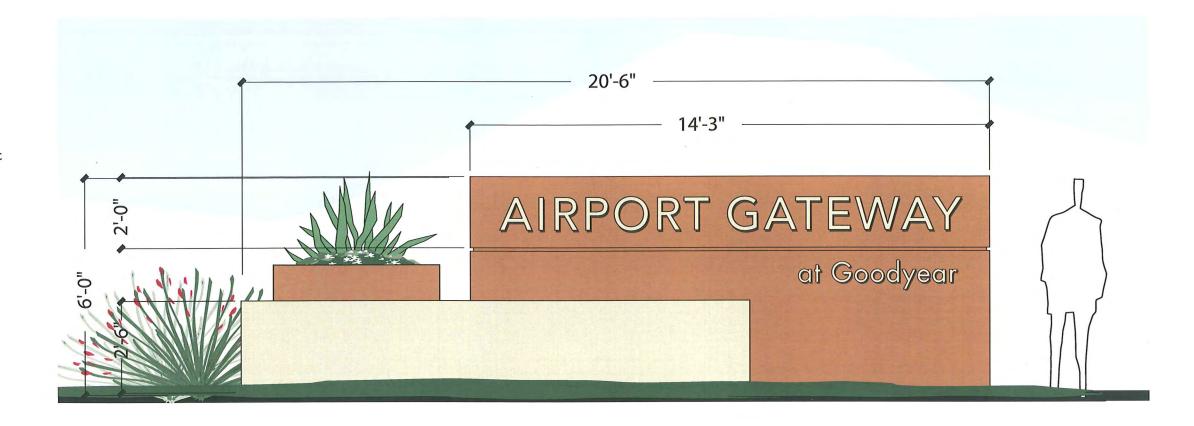

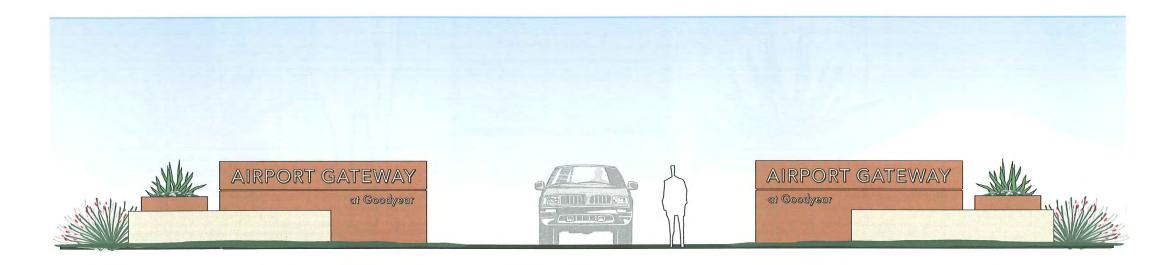

Sign Type 4 - Overall Project Directionals

This sign type will be located along the main interior roadways throughout the site at major decision points for vehicular traffic. This sign shall be used to guide visitors to major destinations and shall be integrated into the surrounding landscaping.

Sizes

Overall Height: 6'-6"

4'-0"x1'-3" 4 at 5 s.f. (20 s.f.) Panels:

Construction

Base:

Masonry fabrication.

Cabinet/Panels: Information:

Aluminum fabrication. Routed in Reflective vinyl applied to cabinet.

Colors

Structure:

Sand Dollar and S'mores

Panels:


Sand Dollar

Information:

Brown or black reflective vinyl.

Illumination

Ground up-lit or none

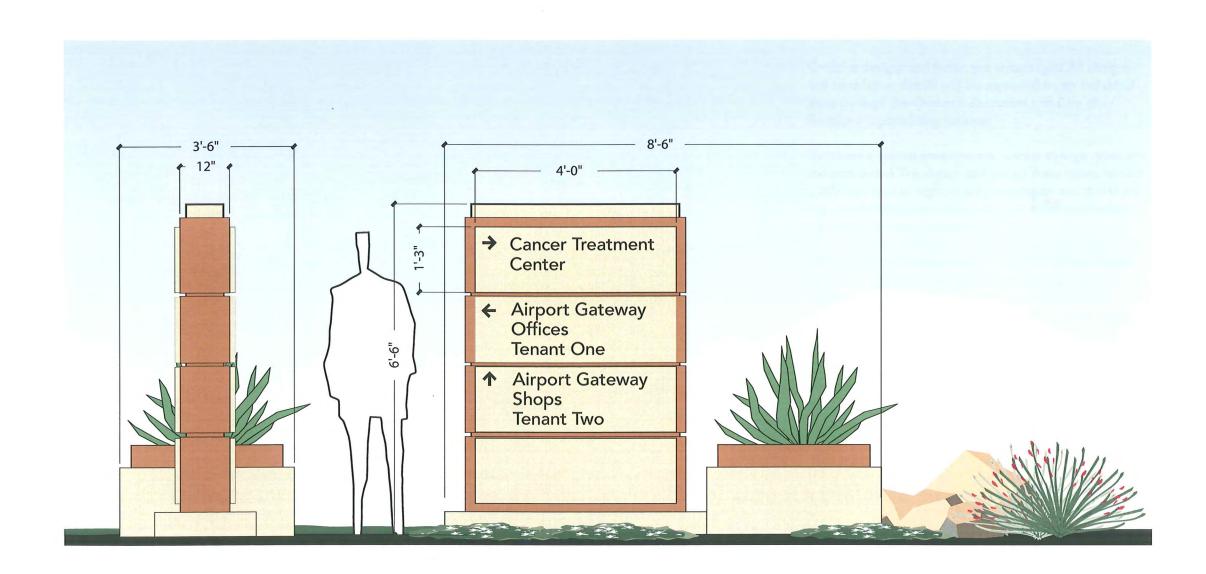

Tenant Storefront Signage Criteria

In order to maintain overall quality and uniqueness in the signage and graphics within Airport Gateway at Goodyear, the following set of guidelines has been developed to be applied to all exterior graphic concerns.

The intent is to establish a sense of quality through creativity and individuality. The results of these guidelines should produce tasteful identity for all users. Recognize that some businesses are small, nonfranchise establishments that depend on their signs' clear communication to bring customers in by allowing the use of varied, well designed, sign types.

Design Practices/Standards

Creative designs and forms are encouraged. All designs and installation details will be approved on an individual basis through the Owner's discretion and City of Goodyear's permitting process.

To create a special environment, unique signage types are recommended. The design and use of these types require a different type of signage area calculation and therefore may be allowed more square footage when applications are made for these tenants.

Also included are those elements, materials and signage types that will not be acceptable unless they can be utilized in such a manner that demonstrates to the Owner that they are in keeping with the overall design quality and criteria.

User Type	Туре	Placement	Area	Quantity	Description /Illumination
Retail/Commercial	Anchor Tenants 75,000+ s.f.	Sign fields must be delineated at time of Final Site Plan review. Primary signage should be centered horizontally and vertically within the architectural frontage on which it is placed. All signage must be located within the Tenant's leased frontage.	One (1) square foot per each lineal foot of the building's front elevation, and one-half (1/2) square foot per each lineal foot for all other elevations. Single tenant usage shall not exceed an aggregate of two hundred (200) s.f. ²	One (I) per tenant on all elevations with readability to public. A maximum of four (4) elevations.	Both individual pan channel, letters and logos; reverse pan channel letters and logos; or custom cabinets shall be allowed. Tenants shall be allowed to use their nationally recognized corporate standard design and colors
	Major Tenants 45,000 - 74,999 s.f. Mini Majors 8,0000 - 44,999 s.f.			One (1) per tenant on all elevations with readability to public. A maximum of four (3) elevations.	Internal backlit, halo or a combination thereof. No exposed raceways.
	Shop/Pad Tenants	Sign fields must be delineated at time of Final Site Plan review. Primary signage should be centered horizontally and vertically within the architectural frontage on which it is placed and/or directly over the doorway if space permits. All signage must be located within the Tenant's leased frontage.		One (I) per tenant on all elevations with readability to public. A maximum of four (4) elevations.	
Mixed Use Office/Medical	Single tenant buildings Multi-tenant buildings (1-2 stories)	Sign fields must be delineated at time of Final Site Plan review. Primary signage should be centered horizontally and vertically within the architectural frontage on which it is placed and/or directly over the doorway if space permits.	One (I) square foot per each lineal foot of the building's front elevation, and one-half (I/2) square foot per each lineal foot for all other elevations. I Single tenant usage shall not exceed an aggregate of two hundred (200) s.f. ²	A maximum of four (4) elevations may have signage.	Dimensional letters/logos (Flat cut out high density foam, acrylics, metals, cast acrylics, or reverse pan channels) ³ Consistent color(s) throughout multi-tenant building or group of buildings. Maximum of two (2) colors shall be
	Multi-tenant buildings (3 or more stories)	Sign fields must be delineated at time of Final Site Plan review. Signage to be allowed on lowermost and uppermost levels that offer signage placement. Primary signage should be centered horizontally and vertically within the architectural frontage on which it is placed and/or directly over the doorway if space permits. All signage may, or may not, be located within the Tenant's leased frontage.		A maximum of two (2) signs per business.	selected from the building/signage color palette that will provide contrast from background surfaces. ³ Designs may be per the individual tenant's corporate design (symbol and typography). Signage to be halo, or non-illuminated, per Owner's discretion. ³ No exposed raceways.
Master Development (signage types allowed throughout the development)	Freeway Signs - Buildings with either main entry or rear elevations directly adjacent to freeway.	On elevations oriented to freeway traffic. Sign fields must be delineated at time of Final Site Plan review. All signage must be located within the Tenant's leased frontage.	One (I) square foot per each lineal foot of the building's front elevation, and one-half (I/2) square foot per each lineal foot for all other elevations. I Single tenant usage shall not exceed an aggregate of two hundred (200) s.f. ²	One (I) sign per elevation.	Internal backlit or halo, or combination
	Awning Signage	Placed on awnings that are integral to the architecture, extending over tenants entry.	Maximum of 25% of front face area of awning may be used for signage.	One (I) per entry.	Shall not be illuminated. Shall not be calculated against tenants allowed aggregate.
	Window Signage	Placed on tenant windows at and around entry areas.	Maximum of 25% of total window area may be used for signage.	N/A	Shall not be illuminated. Shall not be calculated against tenants allowed aggregate.

- I Sign proportions restricted to 70% vertical height and 80% horizontal width of architectural space installed upon.
- 2 Larger square footage exceptions and alternate sign locations may be considered for major tenants or single user tenants on an individual basis upon approval of the Owner and the City Goodyear.
- 3 Exceptions may be made to allow major single tenant office and medical users to use pan channel face-lit letters and logos, and their corporate standard colors, based on approvals by the Owner and the City of Goodyear.

Letter and Logo Standards

All retail tenants shall have building mounted signs fabricated as pan-channel/reverse pan-channel letters and logos, flat cut-out metal, and/or "custom" cabinets. Office tenants shall utilize reverse pan-channel letters and logos. Exceptions may be made, however, to allow major single tenant office or medical users to use pan-channel letters, based on approvals from the Owner and the City of Goodyear.

Construction

Individual letters and logos must be constructed with sheet aluminum returns and retainers. Minimum material thicknesses to be .090 for faces and .050 for letter and graphic returns. Flat cut out metal letters shall be a minimum I" thick. No "Channelume," "Letteredge," or similar material will be allowed.

Individual letters and logos shall not project from the face of the building more than 8" for those utilizing a concealed raceway, and 12" for self contained letters or cabinets. Depth of letters and logos for any one project should be consistent throughout to maintain design continuity and higher level of quality.

Threaded rods or anchor bolts shall be used to mount sign letters, which are spaced out from the building face. Angle clips attached to letter sides will not be permitted. All mounting attachments shall be sleeved and painted.


Illumination

Lighting for wall mounted individual letters can either be internally backlit, halo illuminated, or a combination thereof. Indirect lighting when integrated into the architecture is also a recommended solution for unique individual letter applications.


Lighting used for all the various applications can be neon, low voltage LED, halogen pin mounted or fluorescent when full spectrum lamps are used.

When using white, all whites will be 6200-6500K.

Typical Pan-Channel Letter Halo Illuminated (Section)

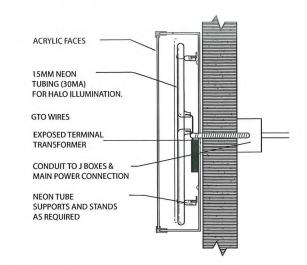

Typical Reverse Pan-Channel Letter Halo Illuminated (Section)

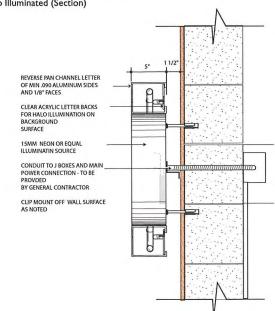

Individual letter examples.



Cabinets must be designed and fabricated with a minimum of three (3) signage/graphic levels, each a minimum of I" deep.

Cabinet face planes must be opaque and contrasting color, texture or material from one another to create depth and dimension.

Unless as part of a nationally registered and/or trademarked logo, rectangular shaped "cabinets" shall not be allowed.

All signs will be approved on an individual basis through owners discretion. Creative designs and forms are encouraged.

Construction

Main identification letters (primary name) shall be dimensional reverse pan or pan channel with a minimum I" thick dimension.

Secondary copy, which is less than 5" in height and/or background graphics, may be routed from the face with either backup or push through acrylic. This does not count as a layer since the depth does not meet the I" minimum depth.

Exposed neon raised off the face of the sign can be used and will be considered a different level, but will be limited to a maximum of ten percent (10%) of the overall sign square footage.

Illumination


Exposed neon tubing shall be permitted subject to Developer/Landlord on custom cabinets only.

Custom cabinets shall be internally illuminated and should be halo illuminated to provide definition of the outer edge of the cabinet.


Installation

All custom cabinets may be installed up to 1 1/2" off face of building to provide for halo illumination.

Typical "Custom Cabinet" section detail for layering, depth and illumination.

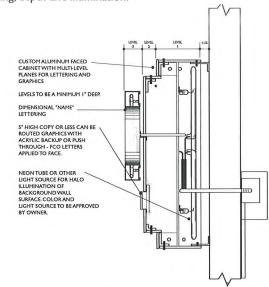

Grazia - Individual letters with cut out aluminum panels with routed/backup copy.

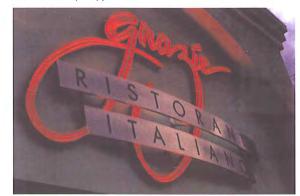

Individual flat cut out planes of distressed metal, halo backlighted.

Individual pan channel letters over layers of custom shapes and banner with routed copy.





Window Signs

No more than 25% of front glass area may have signage/graphics, applied to, or within three (3) feet behind the window area. This includes temporary signage applications for sales, promotions and/or any permanent identification signage. Permanent identification signage may include the name of the establishment, hours of operation, suite numbers, logos and other graphic elements.

This signage does not count against the tenant's square footage allotment.


Printed menus are not allowed to be taped to windows. Menus for take-out or eat-in restaurants, or in-store services must be within an architecturally integrated, enclosed design element. These may be internally illuminated.

Colors and Layouts


For retail applications, colors should be used aesthetically and effectively within the tenant's corporate colors and graphic standards.

For office/medical applications, colors should be kept to a standard white or subdued color consistently used throughout the building or complex.

Typical retailwall sign application example

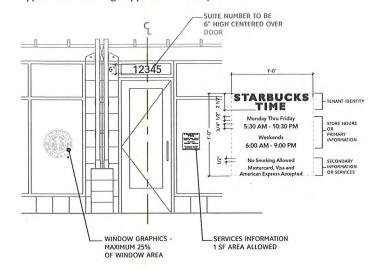

Typical office wall sign application example

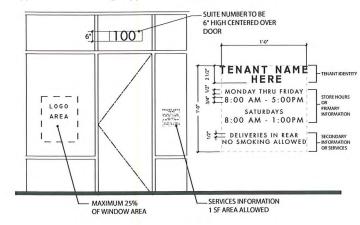

Service Door Signage (Retail)

Service/back doors to Tenant spaces throughout the project shall be standard 5" address number, and 4" name identification (may also include and additional information as required by local jurisdiction). Shall be installed by the Landlord. Typeface to be Avenir 65 Medium.

The Tenant shall not apply any signage or other wording to service doors.

Building Addressing

Building Identification Address Numerals to be individual reverse pan channels with optional neon halo backlighting for night time visibility based on Owner's option.


Numeral height shall be a minimum twelve inches (12").

Returns shall be three inches (3") deep and mounted one and one-half (1-1/2") inches off background wall. (See standard letter construction details.)

Numerals shall be located on the corner of the building facing the nearest major street, to be visible to approaching emergency response vehicles. Quantity shall be determined by the Fire Marshall based on the site plan.

Color of numerals shall provide contrast to the background surface for visibility.

Typeface to be consistent throughout Airport Gateway at Goodyear is Avenir 65 Medium.

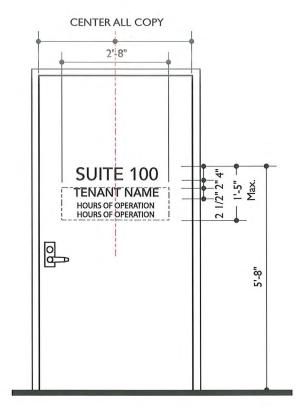

1234567890

Project Graphic Standards/General Requirements

All tenants, of all user types, within Airport Gateway at Goodyear shall adhere to the following graphic standards and general requirements & procedures in creating their individual signage packages.

The graphics standards set forth are good design practices for lettering sizes, proportions and design techniques to provide quality signage for identification graphics for all Owners/Occupants and Tenants within Airport Gateway at Goodyear.

The general requirements includes procedures, restrictions and stipulations for the whole project which will ensure a quality development for the Owner as well as the City of Goodyear.

Colors & Typography

For retail tenants, colors, letter styles and logos shall be per the tenant's registered corporate standards. Faces and returns should be consistent in color to create a more quality oriented design and manufactured product.

For office users, letter styles and logos may be per tenants corporate standards. If the tenant has no such standard, the typeface Avenir 85 Heavy shall be utilized.

Avenir 85 Heavy ABCDEFGHIJKLMNOPQRSTUVWXYZ abcdefghijklmnopqrstuvwxyz 1234567890

Consistent in color(s) throughout multi-tenant building or group of buildings, containing a maximum of two (2) colors which shall be selected from the building/signage color palette that will provide contrast from background surfaces. Exceptions may be made, however, to allow major single tenant office or medical users to use their corporate standard colors, based on approvals from the Owner and the City of Goodyear.


Location


Primary identification for retail applications should be centered, whenever possible, over main entry. These locations provide wayfinding to the establishment. See page 9 for specific location criteria.

Architectural Sign Size

The overall height of any sign layout (single or multiple lines of copy, graphics or custom cabinets) should be based on a maximum vertical height and horizontal width, utilizing good design proportions of the architectural fascia, wall, or sign area it is installed upon.

Acceptable proportions shall not exceed a maximum of seventy-five percent (75%) of the vertical height and an overall length held to a maximum of eighty percent (80%) of the area which it is installed upon.

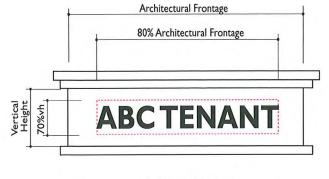

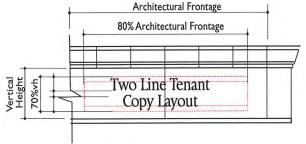

Sign Area Calculation

Where a sign consists "Standard and or typical" signage applications of individual letters, numerals, symbols, or other similar components, the total area of the sign shall be the sum of the areas of the squares or rectangles surrounding each individual component.



Layout/Design Standards

store will not be allowed.

A minimum of one half letter height line spacing will be used between all multiple lines of signage layouts, unless corporate standards (Owner's nationally registered trademark) create a unique circumstance.

Occasional ascenders and descenders, or logo details (maximum of 4%) will be allowed to go beyond the sign envelope, but must be counted as square footage and may not be closer than three inches (3") from break or delineation of architecture.



Signage layouts must include a name for the store and can not be descriptive only. For example INSURANCE, NAILS, TANNING SALON, as the sole identifier for the

NAIL SALON

Bold and blocky san serif as service ID only - not allowed



San serif font used with a name and style - allowed

Tag lines shall be allowed on an individual basis only and are subject to Landlord approval. Any allowable tag lines shall be individually illuminated or non-illuminated and shall not exceed 10" in height. The width of the tag, if approved, shall not exceed 75% of the width of the fascia on which it is installed

Tag lines of services or individual products for sale within the store will not be allowed unless part of the nationally registered trade or service mark. Proof of registration will be required.



SALLEY HANSON-LOREAL LANCOME

Letter Spacing/Kerning

To fit layout standards, lettering and/or logo may not be condensed more than 90% of horizontal letter width of original design.

Examples below illustrate a name that is allowed a maximum letter height of 24" within a designated maximum length. The graphics show what is allowed for fitting the lettering within that space, based on the tenants registered trademark/logo.





ACCEPTABLE LAYOUT SLIGHTLY REDUCED LETTER AT 90% HORIZONTAL SPACING



UNACCEPTABLE LAYOUT
MAX. LETTER-TOO TIGHT KERNING AND AT 90% HORIZONTAL SPACING



UNACCEPTABLE LAYOUT
MAX. LETTER-80% HORIZONTAL SPACING

13

General Sign Standards and Requirements

All signs at Airport Gateway at Goodyear must be compatible with the standards outlined in these Comprehensive Signage Standards and in conformance with the Declaration of Restrictions and Easements. The purpose of the sign standards is to ensure an attractive shopping environment and to protect the interests of the surrounding neighborhood, Developer, and Owners/ Occupants of all parcels within Airport Gateway at Goodyear. Conformance will be strictly enforced, and any installed nonconforming or unapproved signs will be brought into conformance at the sole expense of the Owner/Occupant.

Before designing signs, all Airport Gateway at Goodyear Owners/Occupants will receive a copy of these signage standards. Sign plans submitted to the Committee for approval must conform to these standards. The Committee may administer and interpret the criteria as it applies to signage designs. All signs must be approved in writing by the Committee prior to application to the City of Goodyear for permitting.

For Committee review, send three (3) sets signage drawings to:

> Owner Attn.: Airport Gateway at Goodyear EIM Development Co. 7419 E. Helm Dr., Suite E Scottsdale, AZ 85260

- I. Signage proposal. Each Owner/Occupant must submit to the Committee three (3) sets of detailed shop drawings showing locations, dimensions, sizes, design, colors, materials, lettering, graphics, conduits, junction boxes, sleeves, and other mounting apparatus of all proposed wall, window, and rear door signs. This submittal must be made at least fifteen (15) days prior to submitting requests for permits or manufacturing.
- 2. Sign contractor's responsibilities. Prior to preparation of signage drawings and specifications, the Owner's/Occupant's sign contractor must review all architectural, structural, and electrical documents as they relate to the building wall and/or storefront at the proposed signage location. In addition, the sign contractor should visit the project site to become familiar with as-built conditions and verify all dimensions.

- 3. Committee review. After review of the signage proposal, the Committee will return one of the three sets of drawings to the Owner/Occupant, marked either "Approved," "Approved as Noted," or "Revise and Resubmit."
- 4. "Approved." If drawings are marked "Approved," the Owner/Occupant is allowed to proceed with sign permitting and then construction and installation in accordance with the drawings.
- 5. "Approved as Noted." If drawings are marked "Approved as Noted," the Owner/Occupant is allowed to proceed with sign permitting and then construction and installation, provided that any modifications noted are incorporated into the design. An applicant that takes exception to the noted modifications may revise and resubmit, as explained below.
- 6. "Revise and Resubmit." If drawings are marked "Revise and Resubmit," the plans will be returned to the Owner/Occupant with comments. The drawings should be revised and resubmitted for Committee approval.
- 7. Openings in building walls. Locations of all openings for conduit and sleeves in building walls must be indicated by the sign contractor on the drawings submitted. The contractor shall install the sign in accordance with the approved drawings.
- 8. Messages. Signs are restricted to advertising either (a) the person, firm, company, or corporation operating the use conducted on the site, or (b) the products sold therein, but not both.
- 9. Owner/Occupant responsibilities for other regulations. The Committee's approval of an Owner's/ Occupant's signage plan does not constitute an implication, representation, or certification by the Committee that those plans are in compliance with applicable statutes, codes, ordinances, or other regulations. Compliance with other regulations is the sole responsibility of the Owner/Occupant for all work performed on the premises by or for the Owner/ Occupant.

- 10. Prohibited signs. No signs, advertisements, notices, or other lettering shall be displayed, exhibited, inscribed, painted, or affixed on any part of the buildings visible from outside the premises, except as specifically approved by the Committee. Signs that are installed without written approval from the Committee, or that are inconsistent with approved drawings, may be subject to removal and reinstallation by the Developer at the Owner's/Occupant's expense. Rude, obscene, offensive, animated, flashing, blinking, rotating, moving, or audible signs; placards; posters; playbills; postings; paintings; flags; signs in public rights-of-way; and fixed balloons are not permitted in any location, whether or not visible from outside the premises. Change-panel signs are prohibited, except at gas stations. Prohibited signs will be removed at the Committee's discretion.
- II. Illuminated signs. The City of Goodyear requires permits for all signs and electrical permits for all signs that are illuminated. It is the Owner's/Occupant's sole responsibility to secure these and any other permits that may be required, and to remain in compliance with these approvals and permits.
- 12. Size limitation. Each Owner/Occupant must limit the area of its sign in accordance with the area allocated for signage. Maximum letter height and length varies according to storefront, but it must not exceed the area allocated for signage. Each Owner/Occupant will be granted a minimum of one sign.
- 13. Labels. No labels are permitted on the exposed surface of signs, except those required by local ordinance. Sets of individual letters shall have one label on an end letter only. These are to be installed in an inconspicuous location.
- 14. Freestanding signs. All freestanding signs must meet applicable setbacks, and their installation must comply with all local building and electrical codes.
- 15. Upkeep and maintenance. Each Owner/Occupant is fully responsible for the upkeep and maintenance of its sign(s), including any individual pylon or monument signage, and Owners/Occupants are to repair any sign defects within five (5) days of notification. If an Owner/

Occupant does not repair said sign(s), the Developer, at the Owner/Occupant's sole cost and expense, may repair and/or replace sign(s). A penalty of 100% of the Developer's cost to repair said signage, in addition to the cost of the repair, may be assessed to the Owner/ Occupant if the Developer or Property Manager is required to provide the necessary maintenance due to the Owner's/Occupant's noncompliance following notification.

- 16. Illumination timer. Power to illuminate the Owner's/Occupant's sign is to be from Owner's/ Occupant's electricity meter, switched through a Tork DW-2100AY time clock, set in accordance with schedules determined by the Developer and shopping center manager.
- 17. Sealing of building penetrations. All penetrations of the building structure required for sign installation shall be neatly sealed in a watertight fashion.
- 18. Damage caused by or during installation. The sign contractor and/or Owner/Occupant will pay for any damage to a building's fascia, canopy, structure, roof, building elements or flashing caused by sign installation.
- 19. Required insurance for sign contractors. All sign contractors must carry workers' compensation and commercial liability insurance against all damages suffered or done to any and all persons and/or property while engaged in the construction or installation of signs, with a combined single limit in an amount not less than two million and no/100 dollars (\$2,000,000.00) per occurrence. Every sign contractor must hold a current contractor's license in the State of Arizona. Landlord or building owner must be named as additionally insured in the workers' compensation and commercial liability insurance.
- 20. Committee's right to modify requirements. The Committee has the right to modify the sign standards and requirements for any Owner/Occupant.

Definitions

The following definitions are used throughout the comprehensive signage plan and are exclusive to this document.

Aggregate Sign Area

The total area of all permitted signs pertaining to any one Owner/Occupant, which includes Street-front signage, Storefront signage (arcade and window signage/graphics).

Architectural Frontage

The portion of the building frontage of the leased space which has been delineated through use of reveals, patterning, materials, finishes, column breaks, etc that creates a special area for signage.

Architectural Awnings

Elements which are constructed of permanent type of materials and are an integral part of the building elevation design.

Building Leased Frontage

The overall lineal foot frontage of a leased space.

Cabinet (Typical)

Acrylic, Plexiglas, or plastic-faced panels with surface or second-surface applied or painted graphics, internally backlit in a box construction.

Custom Cabinet

Cabinet designed and fabricated in multiple planes, colors, finishes and unique shapes and forms. Typically with dimensional illuminated letters and opaque backgrounds.

Committee

7

Made up of the consenting owners as defined in the Construction, Operation and Reciprocal Easement Agreement.

Graphics

Lettering, symbols, and logos used for name identification (primary identification), and for identification of product and services (secondary identification or modifiers).

Sign Area

The aggregate area of the smallest rectangles that encloses individual elements of a sign's lettering and logos.

Sign Envelope

The overall height and length allowances of sign area designated for Owner/Occupant sign placement on a building elevation.

Street Front Signage


Signage installed parallel to the building fascia, typically located along the front of the building on parapet, fascia or building wall intended for the viewing of vehicular traffic.

Storefront Signage & Graphics- Permanent

This is the signage located along the storefront portion, oriented to pedestrian. It includes the transparent portion of storefront (windows) and/or solid wall areas used for merchandise display and permanent graphics. This includes awnings, tenant suite number, logo and name identification, secondary name modifiers, hours of operation, services or name brand marketing, menu cabinets, etc.

Storefront Signage & Graphics - Temporary

Any sign, banner, pennant, balance or advertising display constructed of cloth, canvas, light fabric, cardboard, wallboard or other like material with or without frames.

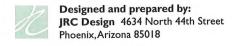

APPENDIX "A"

v 1.3 - 061319



SIGNAGE CONSULTANT:



Cancer Treatment Centers of America Comprehensive Care and Research Center 14200 W. Celebrate Life Way Goodyear, Arizona



9650 WEST ROOSEVELT STREET TOLLESON, ARIZONA 85353 602-944-3117 FAX 602-395-0753 SALES@BLEIERINDUSTRIES.COM Western Regional Medical Center Cancer Treatment Centers of America 14200 W. Fillmore St. Goodyear, AZ

Overall Freestanding Sign Location Plan

2008-D-007

AIRPORT GATEWAY CSP

ST3.2

ST2.2

AMENDMENT


REV 6/2019

gn Location Plan SALES: Paul Bleier SCALE: NTS 09/12/08
SHEET No:

SP-1

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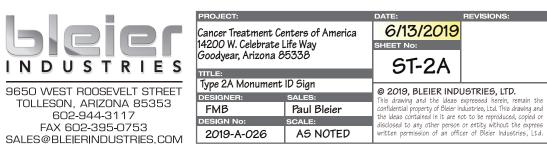



SPECIFICATIONS:

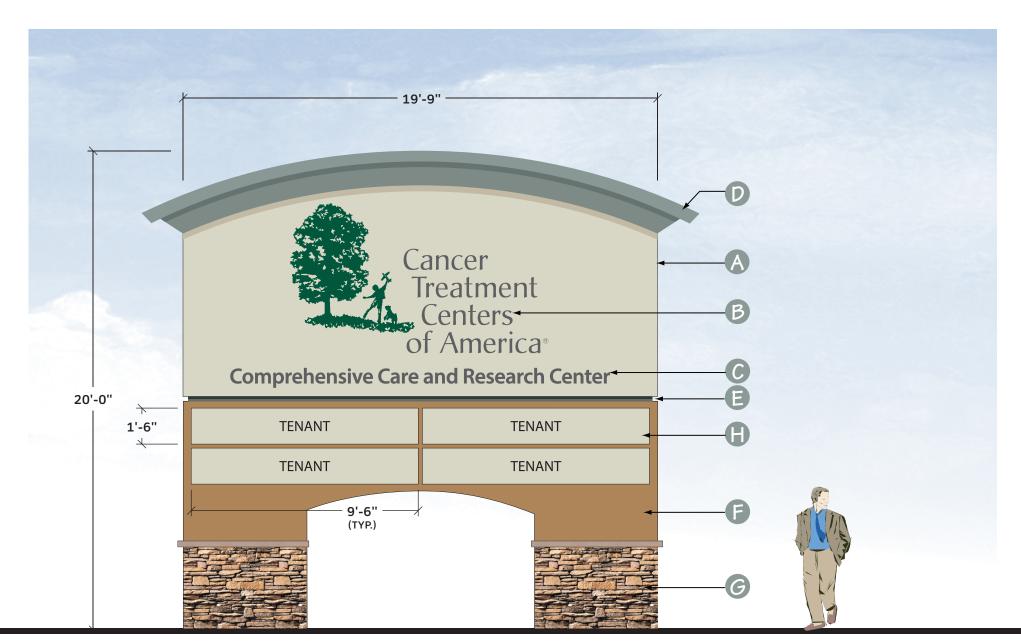- INTERNALLY ILLUMINATED SIGN CABINET TEXTURED AND PAINTED TO MATCH DRIVIT 449 BUCKSKIN
- ROUTED COPY 1" PUSH THRU W/ 1ST SURFACE APPLIED VINYL OVER ACRYLIC BACK-UP
- FCO PIN MOUNT 1/2" PAINTED ALUMINUM, NON-ILLUMINATED
- DECORATIVE CORNICE TEXTURED AND PAINTED TO MATCH HEMLOCK GREEN
- ALUMINUM REVEAL TEXTURED AND PAINTED TO MATCH HEMLOCK GREEN
- ALUMINUM BASE TEXTURED AND PAINTED TO MATCH DRIVIT 375 SPICE TAN
- DRYSTACK SOUTHERN LEDGESTONE RUSTIC CSV-2055
- FUTURE MULTI-TENANT PANELS PAINTED TO MATCH DRIVIT 449 BUCKSKIN

TYPE 2A MONUMENT SIGN Scale: 1/4" = 1'-0"





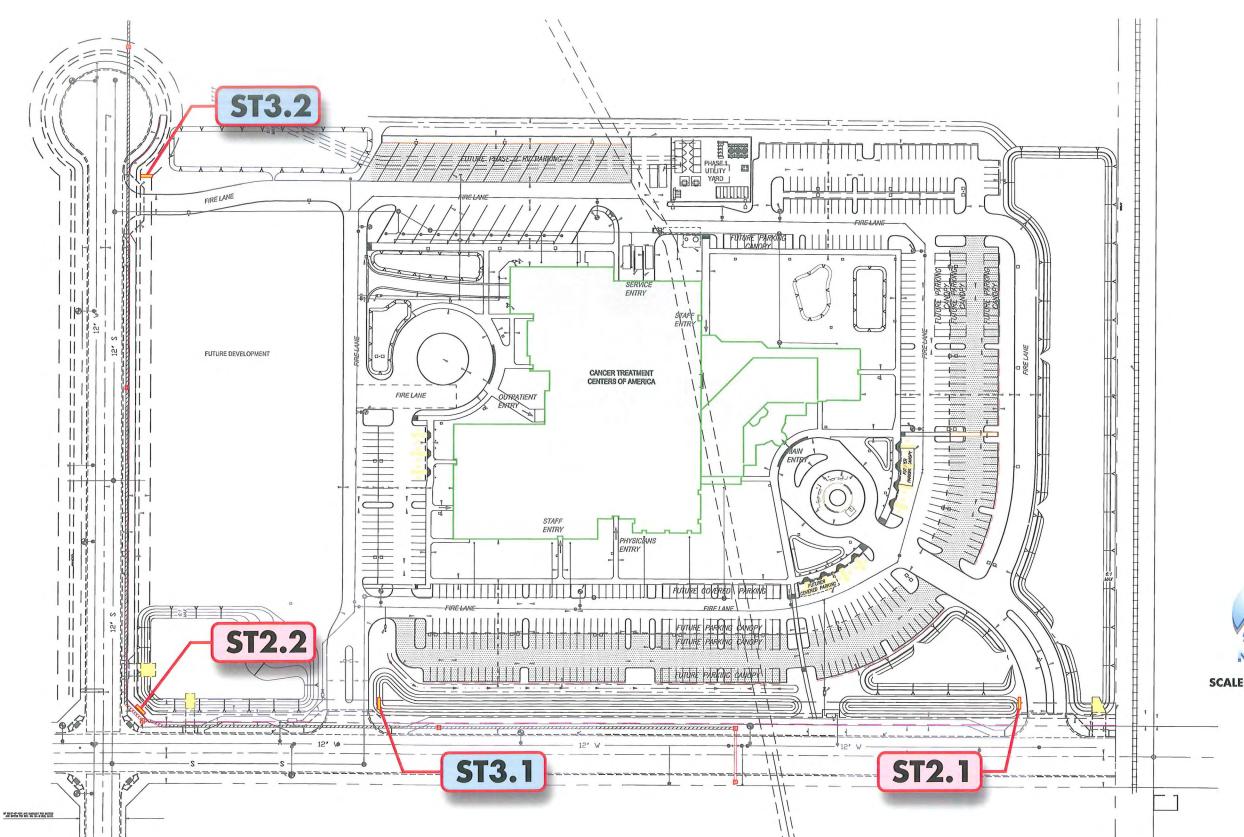




9650 WEST ROOSEVELT STREET TOLLESON, ARIZONA 85353 602-944-3117 FAX 602-395-0753 SALES@BLEIERINDUSTRIES.COM

Western Regional Medical Center Cancer Treatment Centers of America 14200 W. Fillmore St. Goodyear, AZ Freestanding Sign - Location Plan Dan Horton Paul Bleier 2008-D-007 09/12/08 AS NOTED SHEET No: **SP-2**

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SCALE: 1" = 120'-0"



TYPE 2.1 - MONUMENT SIGN SCALE: 1/4" = 1'-0"

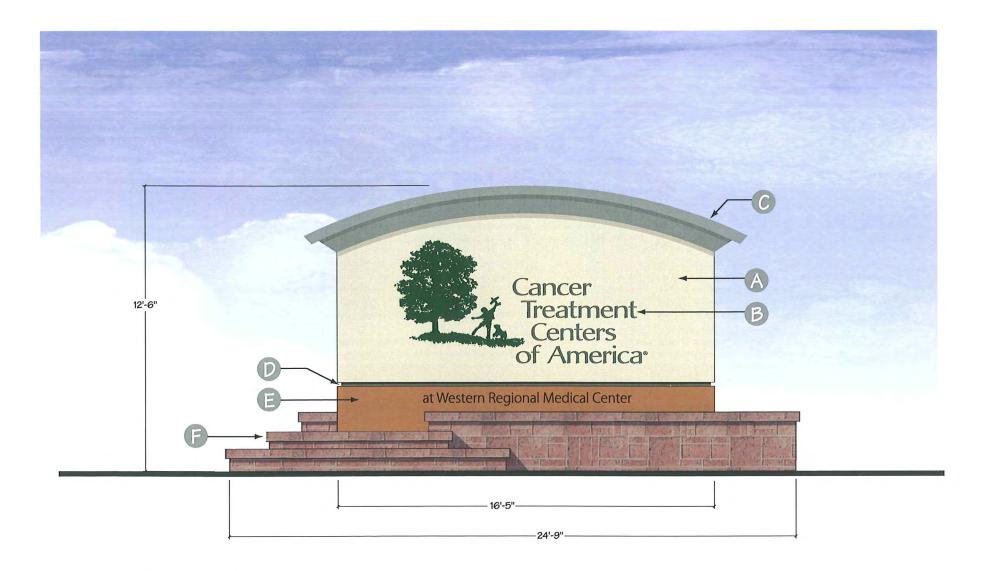
SPECIFICATIONS:

- A INTERNALLY ILLUMINATED SIGN CABINET TEXTURED AND PAINTED TO MATCH DRIVIT 449 BUCKSKIN
- ROUTED COPY WITH FIRST SURFACE APPLIED VINYL OVER ACRYLIC BACK-UP
- DECORATIVE CORNICE TEXTURED AND PAINTED TO MATCH HEMLOCK GREEN
- ALUMINUM REVEAL TEXTURED AND PAINTED TO MATCH HEMLOCK GREEN
- ALUMINUM POLE COVER TEXTURED AND PAINTED TO MATCH DRIVIT 375 SPICE TAN
- DECORATIVE STONE/TILE BASE TO MATCH BUILDING PALETTE



9650 WEST ROOSEVELT STREET TOLLESON, ARIZONA 85353 602-944-3117 FAX 602-395-0753

	PROJECT:	True I have been	DATE:	REVISIONS:
	Western Regional	Medical Center Centers of America	09/12/08	
	14200 W. Fillmore	Centers of America	SHEET No:	
S	14200 W. Fillimore	51. Goodyear, AZ	ST-2.1	
3	TITLE:		91-2.1	
	Type 2.1 - Monument S	ign	0 0000 BI FIFR IN	DUCTRIEC ITD
: 1	DESIGNER:	SALES:	© 2008, BLEIER IN	expressed herein, remain the
	Dan Horton	Paul Bleier	confidential property of Bleier	Industries, Ltd. This drawing and not to be reproduced, copied or
	DESIGN No:	SCALE:	disclosed to any other person	not to be reproduced, copied or
NA	2008-D-007	AS NOTED	written permission of an off	or entity without the express icer of Bleier Industries, Ltd.

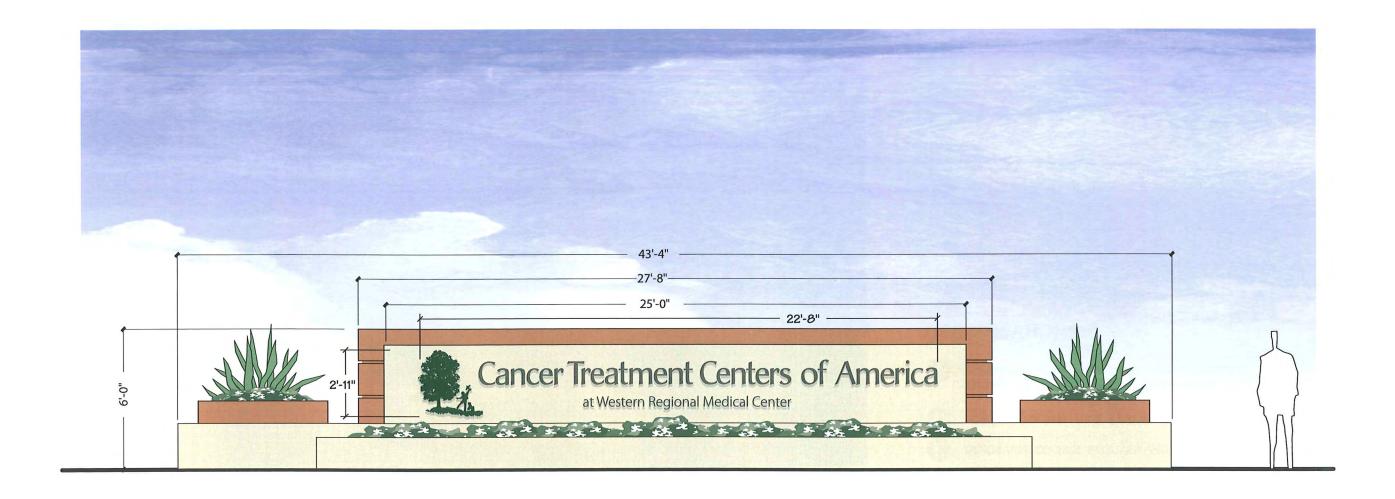

TYPE 2.2 - MONUMENT SIGN SCALE: 1/4" = 1'-0"

Sizes

Overall Height: 6'-0"

ID Area: 25'-0"x3'-3" 80 s.f.

Construction

Structure: Masonry fabrication.

ID Letters: Reverse pan channel dimensional letters,

pin mounted off surface.

Colors

Structure:

Sand Dollar and S'mores

ID Letters: S

S'mores


Illumination

Halo, ground up-lit or combination



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PROJECT:		DATE:	REVISIONS:
Western Regiona	Medical Center t Centers of America	09/12/08	
	St. Goodyear, AZ	SHEET No:	
14200 W. Fillmon	e St. Goodyear, AL	ST-2.2	
TITLE:		31-2.2	10 / 10
Type 2.2 - Monument	Sign	© 2008, BLEIER I	UDUCTRIEC ITD
DESIGNER:	SALES:		NDUSTRIES, LID. as expressed herein, remain the
Dan Horton	Paul Bleier	confidential property of Bleis	er Industries, Ltd. This drawing and
DESIGN No:	SCALE:	disclosed to any other nen	e not to be reproduced, copied on son or entity without the express
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TYPE 3.1 - DIRECTIONAL SIGN SCALE: 3/8" = 1'-0"


SPECIFICATIONS:

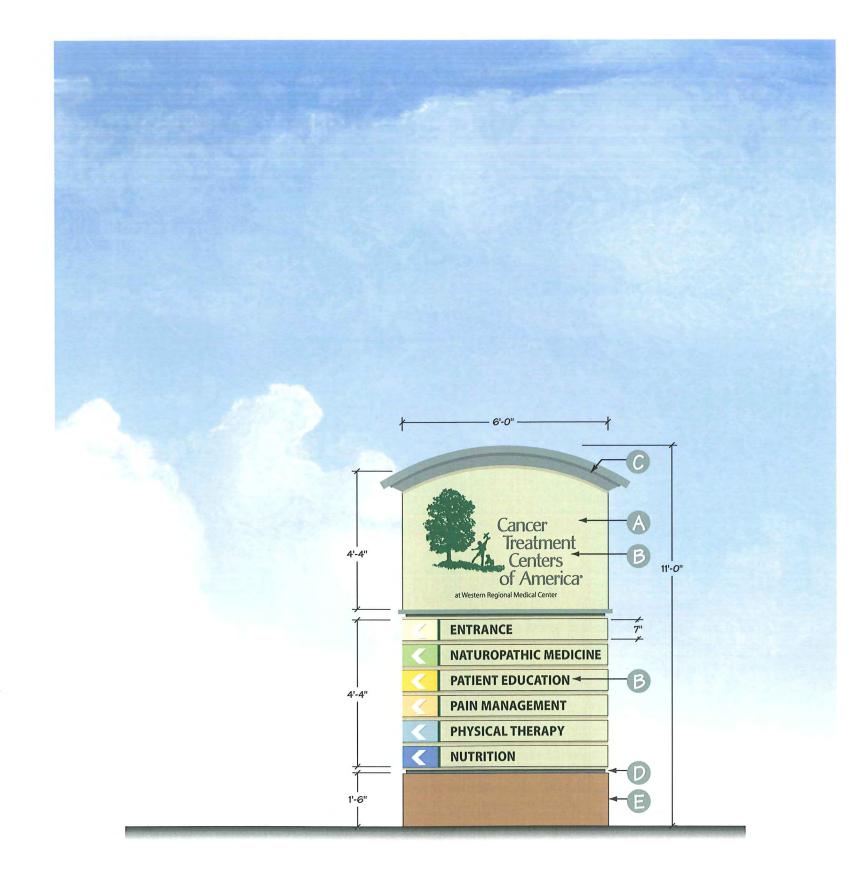- AND PAINTED TO MATCH DRIVIT 449 BUCKSKIN
- ROUTED COPY WITH FIRST SURFACE APPLIED VINYL OVER ACRYLIC BACK-UP
- DECORATIVE CORNICE TEXTURED AND PAINTED TO MATCH HEMLOCK GREEN
- ALUMINUM REVEAL TEXTURED AND PAINTED TO MATCH HEMLOCK GREEN
- ALUMINUM POLE COVER TEXTURED AND PAINTED TO MATCH DRIVIT 375 SPICE TAN



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PROJECT:		DATE:	REVISIONS:	
Western Regional Cancer Treatmen	Medical Center Centers of America	09/12/08		
14200 W. Fillmore	St. Goodyear, AZ	ST-3.1	1	
Type 3 - Directional Pole Sign				
DESIGNER:	SALES:	© 2008, BLEIER IN	IDUSTRIES, LTD. s expressed herein, remain the	
Dan Horton Paul Bleier DESIGN No: SCALE:		confidential property of Bleier Industries, Ltd. This drawing a		
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2008-D-007 AS NOTED		written permission of an of	fficer of Bleier Industries. Ltd.	

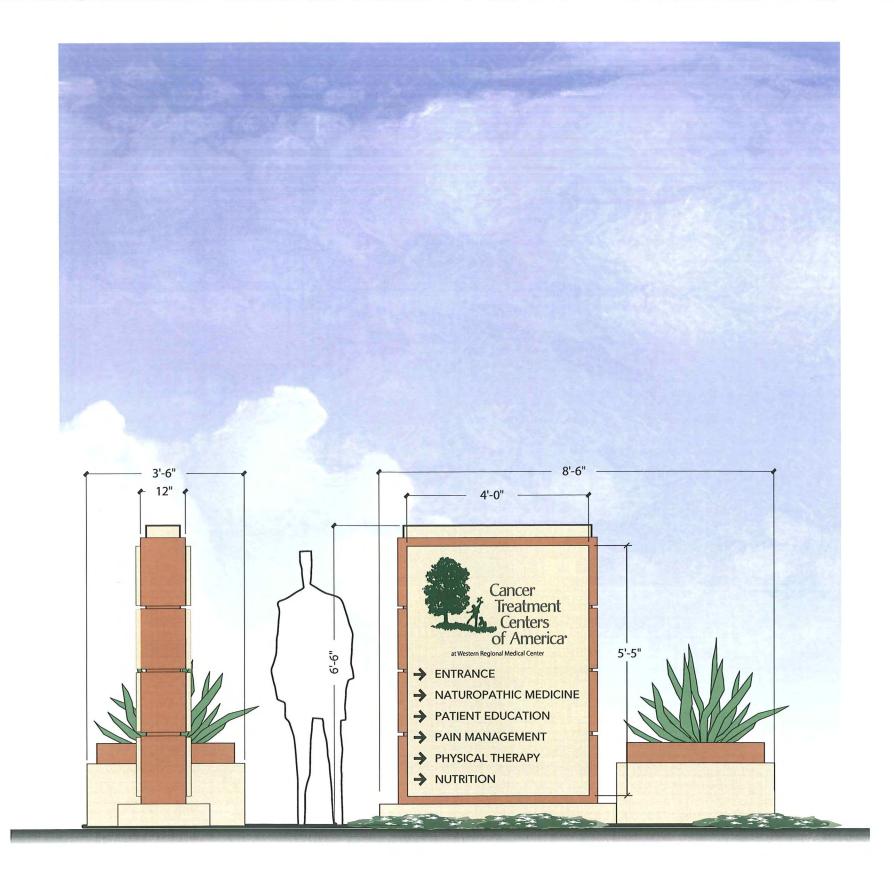

TYPE 3.2 - DIRECTIONAL SIGN SCALE: 3/8" = 1'-0"

Sizes

Overall Height: 6'-6"

4'-0"×7'-3" 4 at 5 s.f. (29 s.f.) Panels:

Construction

Base: Masonry fabrication.

Cabinet/Panels: Aluminum fabrication. Routed in Reflective vinyl applied to cabinet or Information:

routed copy with acrylic back-up, TBD.

Colors

Sand Dollar and S'mores Structure:

Sand Dollar Panels:

Information: Brown or black reflective vinyl.

Illumination Internal or Ground up-lit or none, TBD


2008-D-007



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PROJECT:		DATE:	REVISIONS:
Western Regional Medical Center Cancer Treatment Centers of America 14200 W. Fillmore St. Goodyear, AZ		09/12/08	
		SHEET No:	
		ST-3.2	
		31-3.2	1
Type 3.2 - Directional Pole Sign DESIGNER: SALLES: Dan Horton Paul Bleier		© 2000 DI FIED IND	LICTOICC LTD
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Western Regional Medical Center Cancer Treatment Centers of America 14200 W. Fillmore St. Goodyear, AZ

Building Sign - Location Plan

Dan Horton Paul Bleier

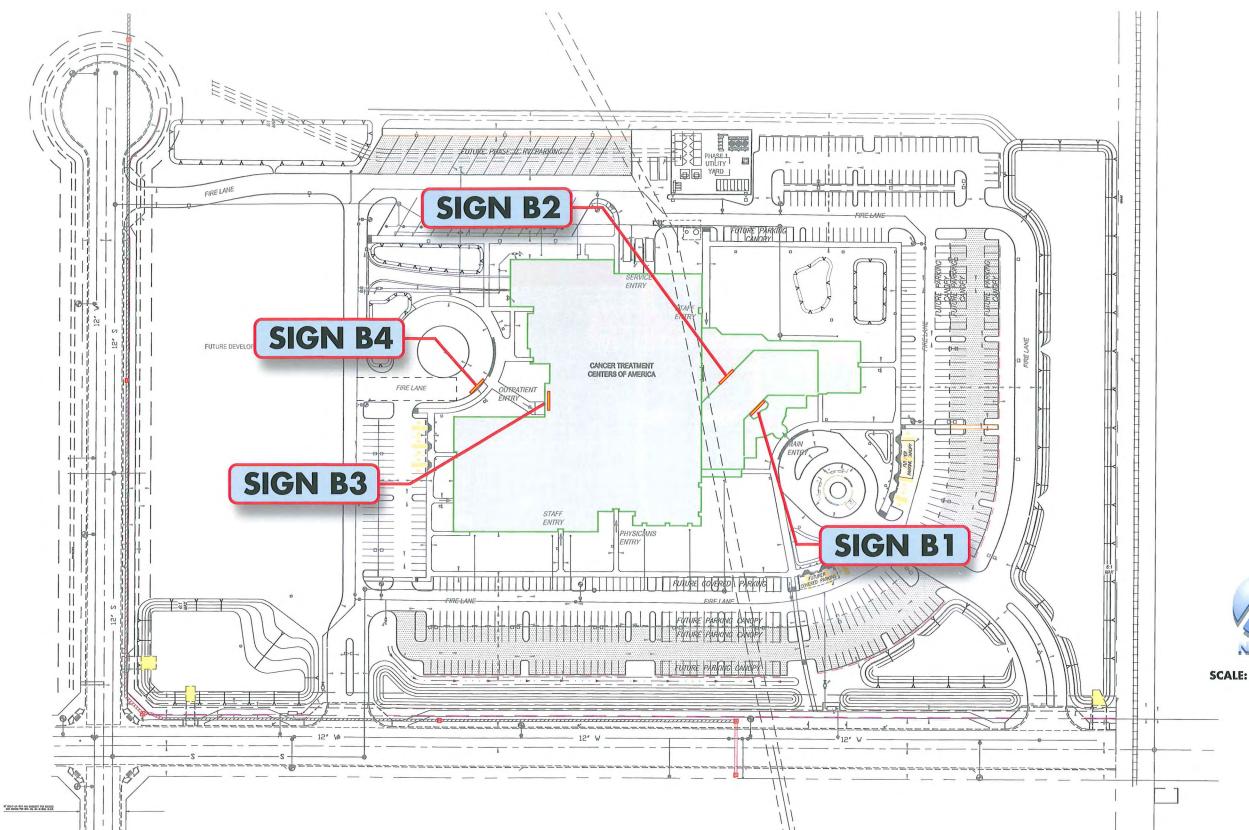08/18/08 2008-D-007

AS NOTED

SP1-BS

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SCALE: 1" = 120'-0"



WESTERN REGIONAL MEDICAL CENTER CANCER TREATMENT CENTERS OF AMERICA

PS∧ **® Dewberry**



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PROJECT:	DATE:	REVISIONS:
Western Regional Medical Center	08/19/08	
Cancer Treatment Centers of America	SHEET No:	
14200 W. Fillmore St. Goodyear, AZ		1

RENDERING Building Elevation @ Main Entry
DESIGNER: SALES:

BLVR-SE

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This drawing and the ideas

 DESIGNER:
 SALES:

 Dan Horton
 Paul Bleier

 DESIGN No:
 SOALE:

 2008-D-007
 NTS


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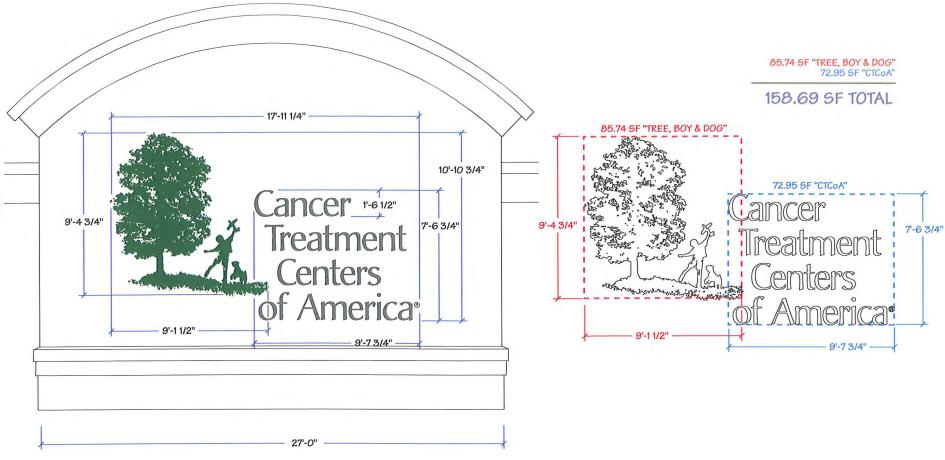


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11/2"-BACKING - LED LIGHT SOURCE 1/4" ALL-THREAD

3/4" PLYWOOD REMOTE -MOUNTED TRANSFORMER 1/4" NUT & WASHER W/SPACER BUSHING MINIMUM 4 PER LETTER

TYPICAL REVERSE PAN CHANNEL LETTER - SCALE: NTS

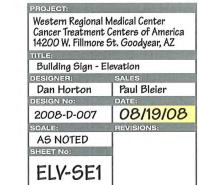

SIGN B1 - ISOLATION - NORTHWEST ELEVATION @ GUEST ACCOMODATION - SCALE: 3/16" = 1'-0"




SOUTHEAST ELEVATION @ GUEST ACCOMODATION - SCALE: 1" = 30'-0"


SIGN B1 SPECIFICATIONS:

HALO-ILLUMINATED REVERSE PAN CHANNEL LETTER

LETTER FACE IS OPAQUE PAINTED METAL

OPEN LETTER BACK ALLOWS LIGHT TO PASS OUT THE BACK OF LETTER TO REFLECT OFF OF WALL SURFACE BEHIND

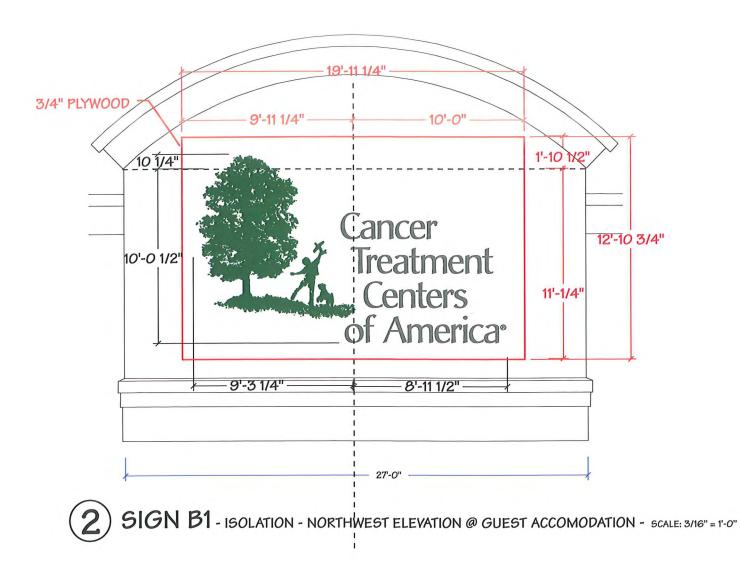

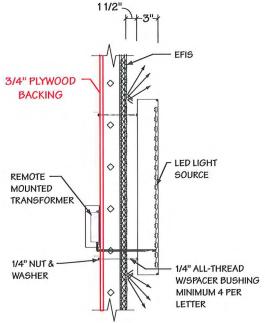

TYPICAL REVERSE PAN CHANNEL LETTER - SCALE: NTS



SIGN B1 SPECIFICATIONS: HALO-ILLUMINATED REVERSE PAN CHANNEL LETTER

LETTER FACE IS OPAQUE PAINTED METAL

OPEN LETTER BACK ALLOWS LIGHT TO PASS OUT THE BACK OF LETTER TO REFLECT OFF OF WALL SURFACE BEHIND

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Paul Bleier

08/19/08

Western Regional Medical Center Cancer Treatment Centers of America 14200 W. Fillmore St. Goodyear, AZ

Building Sign - Elevation


Dan Horton

2008-D-007

AS NOTED

ELV-SE1-PW

SOUTHEAST ELEVATION @ GUEST ACCOMODATION - SCALE: 1" = 30'-0"

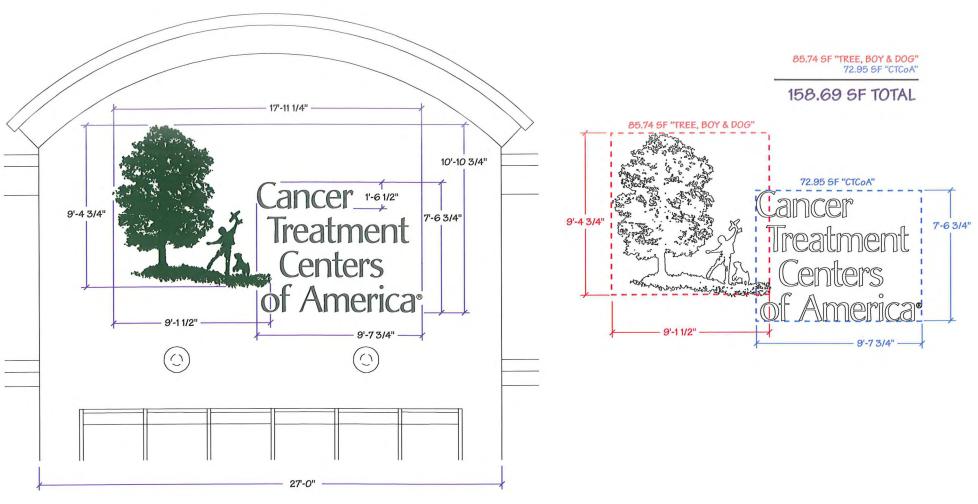

3/4" PLYWOOD

BACKING

REMOTE

MOUNTED

TRANSFORMER

1/4" NUT &
WASHER

WASHER

1/4" ALL-THREAD
W/SPACER BUSHING

INDUSTRIES

9650 WEST ROOSEVELT STREET TOLLESON, ARIZONA 85353 602-944-3117

FAX 602-395-0753

SALES@BLEIERINDUSTRIES.COM

Western Regional Medical Center
Cancer Treatment Centers of America
14200 W. Fillmore St. Goodyear, AZ

TITLE:
Building Sign - Elevation
DESIGNER:
Dan Horton
Paul Bleier
DESIGN No:
DATE:
2008-D-007
08/19/08

AS NOTED

ELV-NW1


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SIGN B2 - ISOLATION - NORTHWEST ELEVATION @ GUEST ACCOMODATION - SCALE: 3/16" = 1'-0"

(3

TYPICAL REVERSE PAN CHANNEL LETTER - SCALE: NTS

MINIMUM 4 PER LETTER

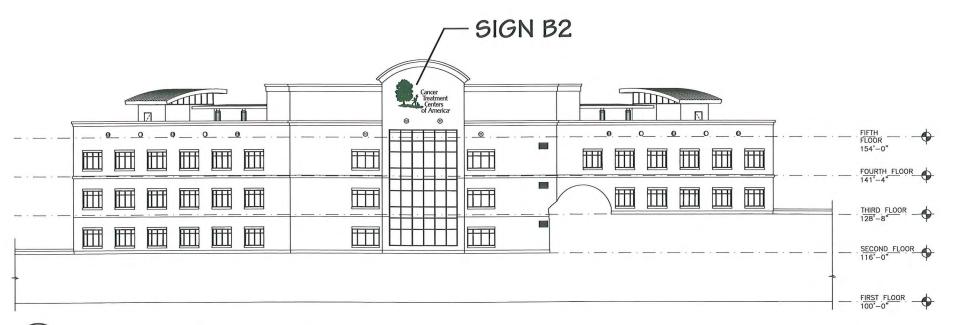



SIGN B2 SPECIFICATIONS: HALO-ILLUMINATED REVERSE PAN CHANNEL LETTER

LETTER FACE IS OPAQUE PAINTED METAL


OPEN LETTER BACK ALLOWS LIGHT TO PASS OUT THE BACK OF LETTER TO REFLECT OFF OF WALL SURFACE BEHIND

1 NORTHWEST ELEVATION @ GUEST ACCOMODATION - SCALE: 1" = 30'-0"

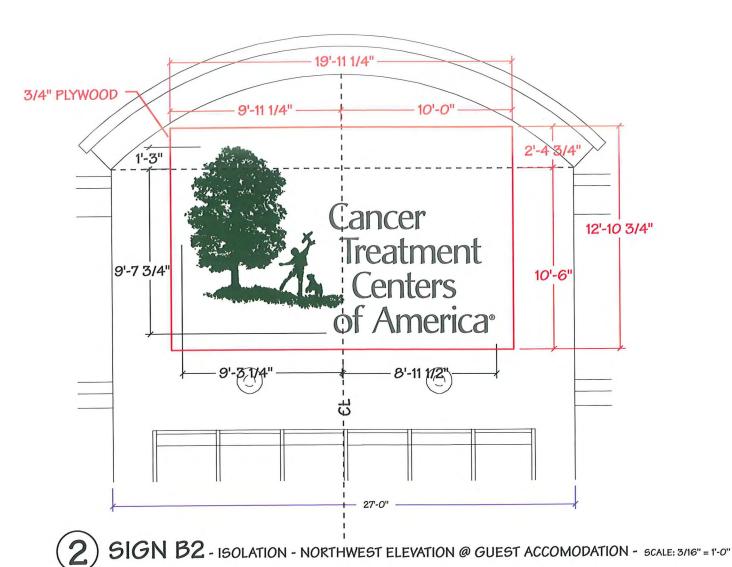

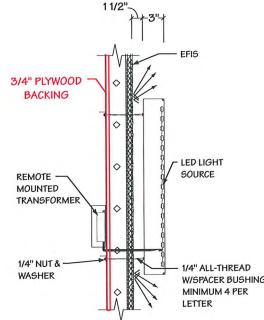

TYPICAL REVERSE PAN CHANNEL LETTER - SCALE: NTS

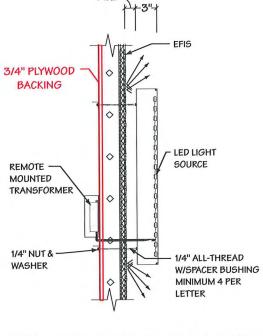



SIGN B2 SPECIFICATIONS: HALO-ILLUMINATED REVERSE PAN CHANNEL LETTER

LETTER FACE IS OPAQUE PAINTED METAL

OPEN LETTER BACK ALLOWS LIGHT TO PASS OUT THE BACK OF LETTER TO REFLECT OFF OF WALL SURFACE BEHIND

NORTHWEST ELEVATION @ GUEST ACCOMODATION - SCALE: 1" = 30'-0"



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FAX 602-395-0753 SALES@BLEIERINDUSTRIES.COM

Western Regional Medical Center Cancer Treatment Centers of America 14200 W. Fillmore St. Goodyear, AZ Building Sign - Elevation Paul Bleier

08/19/08 2008-D-007

AS NOTED

ELV-NW1-PW

Dan Horton

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Outpatient Entry


WESTERN REGIONAL MEDICAL CENTER
CANCER TREATMENT CENTERS OF AMERICA

PSA **Dewberry**



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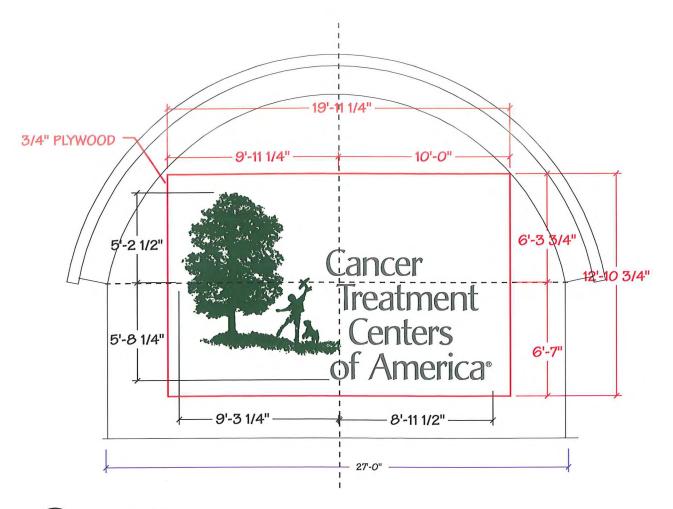
PROJECT:		DATE:	REVISIONS:
14200 W. Fillmore St. Goodyear, AZ		08/19/08	3
		SHEET No:	
		ELVR-W	
		ELA V-A	V
RENDERING Building Ele	vation @ Outpaitient Entry	© 2008, BLEIER INDUSTRIES, LTD.	
DESIGNER: SALES:		This drawing and the	ideas expressed herein, remain th
Dan Horton	Paul Bleier	confidential property of Bleier Industries, Ltd. This drawing the ideas contained in it are not to be reproduced, con disclosed to any other person or entity without the written permission of an officer of Bleier Industries,	
DESIGN No:	SCALE:		
2008-D-007	NTS		

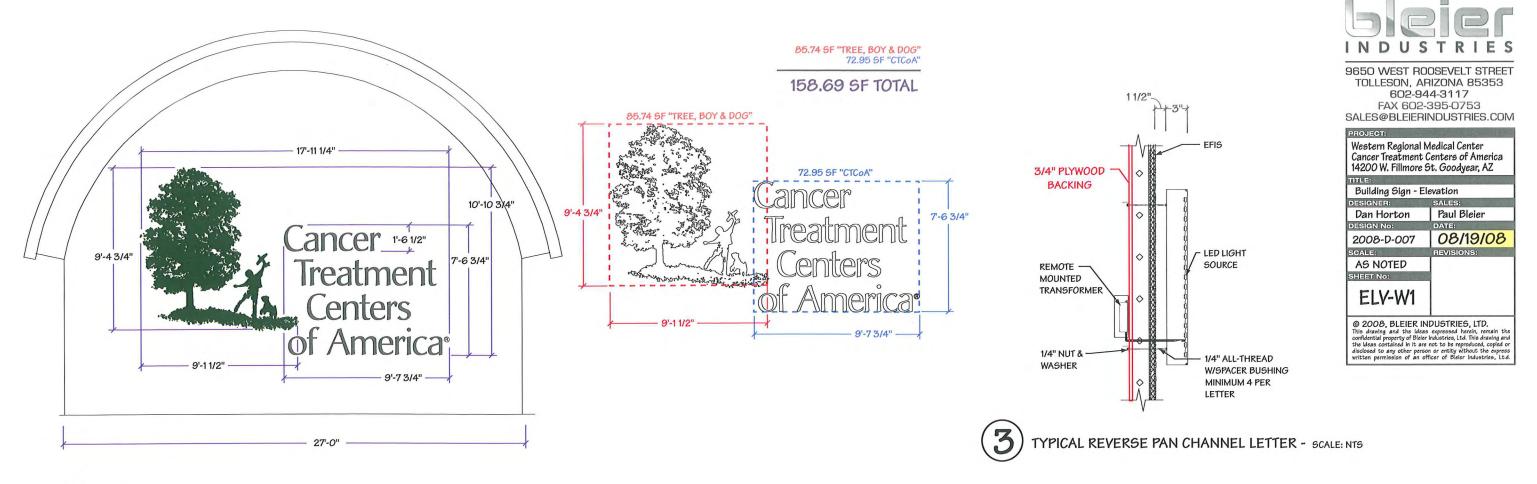


2 SIGN B3 - ISOLATION - WEST ELEVATION - SCALE: 3/16" = 1'-0"




1 WEST ELEVATION - SCALE: 1" = 30'-0"



2 SIGN B3 - ISOLATION - WEST ELEVATION - SCALE: 3/16" = 1'-0"

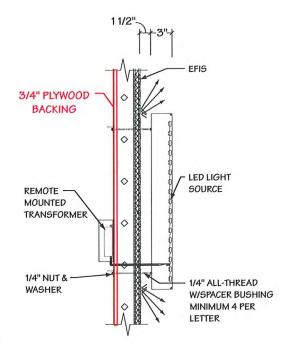

TYPICAL REVERSE PAN CHANNEL LETTER - SCALE: NTS

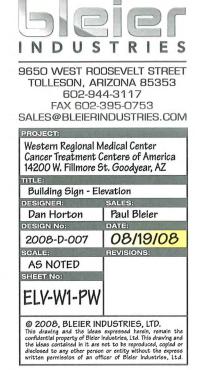

SIGN B3 SPECIFICATIONS: REVERSE PAN CHANNEL LETTER



WEST ELEVATION - SCALE: 1" = 30'-0"



6.25 SF


REVERSE PAN CHANNEL LETTER - SCALE: 1/2" = 1'-0"

SIGN B4 SPECIFICATIONS:
NON-ILLUMINATED REVERSE PAN CHANNEL LETTER

LETTER FACE IS OPAQUE PAINTED METAL



TYPICAL REVERSE PAN
CHANNEL LETTER SECTION - SCALE: NTS

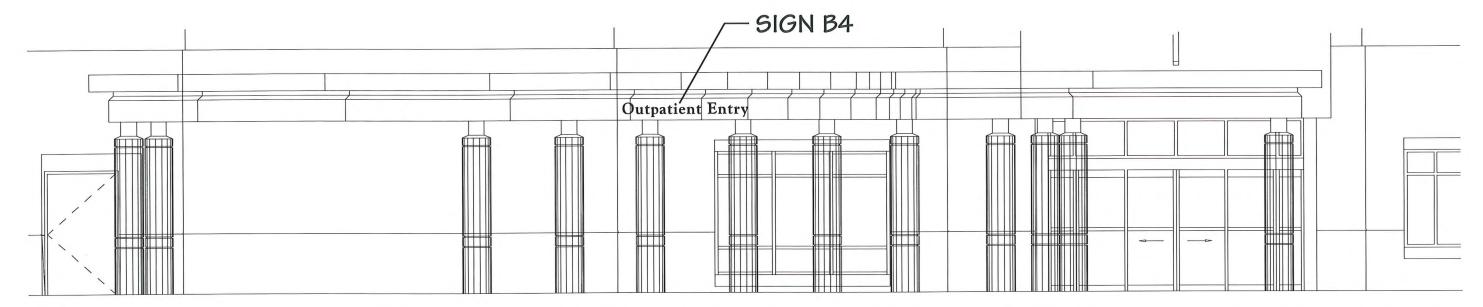

2) SIGN B4 - ISOLATION - WEST ELEVATION - SCALE: 3/16" = 1'-0"





9650 WEST ROOSEVELT STREET TOLLESON, ARIZONA 85353 602-944-3117 FAX 602-395-0753

SALES@BLEIERINDUSTRIES.COM

Western Regional Medical Center Cancer Treatment Centers of America 14200 W. Fillmore St. Goodyear, AZ TITLE: Building Sign - Elevation

DESIGNER:	SALES:
Dan Horton	Paul Bleier
DESIGN No:	DATE:
2008-D-007	08/19/08
SCALE:	REVISIONS:

AS NOTED SHEET NO:

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ADDRESS NUMERALS TO BE LOCATED ON BUILDING PER DIRECTION OF FIRE MARSHAL




1 ADDRESS NUMERAL SPECIFICATIONS: NON-ILLUMINATED REVERSE PAN CHANNEL LETTER

14 SF

LETTER FACE IS OPAQUE PAINTED METAL - COLOR TO MATCH BUILDING PALETTE ACCENT COLOR

FONT IS MYRIAD - ROMAN

QTY: 2

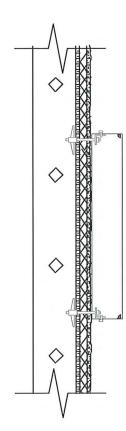





9650 WEST ROOSEVELT STREET TOLLESON, ARIZONA 85353 602-944-3117 FAX 602-395-0753 SALES@BLEIERINDUSTRIES.COM

Western Regional Medical Center
Cancer Treatment Centers of America
14200 W. Fillmore St. Goodyear, AZ
TITLE:
Building Address Numerals
DESIGNER:
Dan Horton
DESIGN No:
DATE:
2008-D-007
SCALE:
REVISIONS:
AS NOTED
SHEET No:

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